


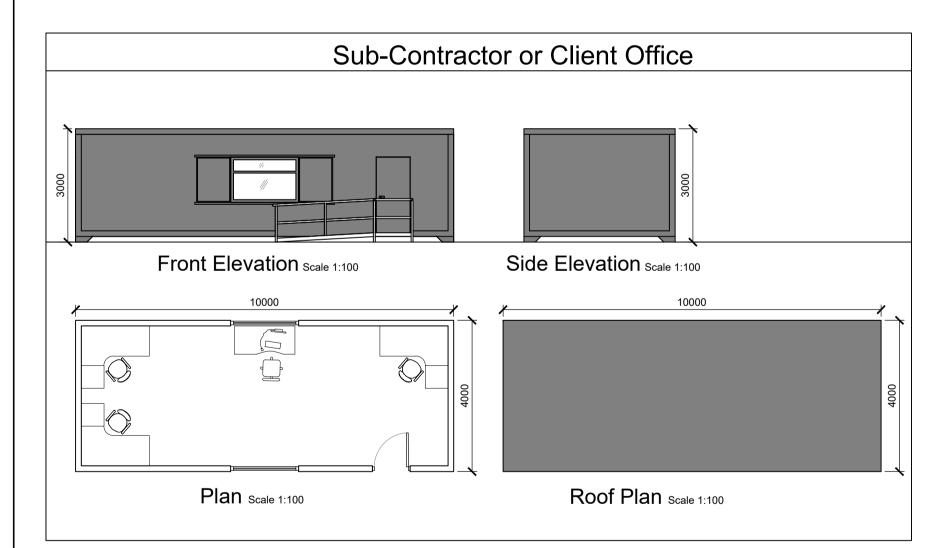



Storage Unit To Be Used On Site




Canteen Area


Side Elevation Scale 1:100


Roof Plan Scale 1:100


Front Elevation Scale 1:100

Plan Scale 1:100

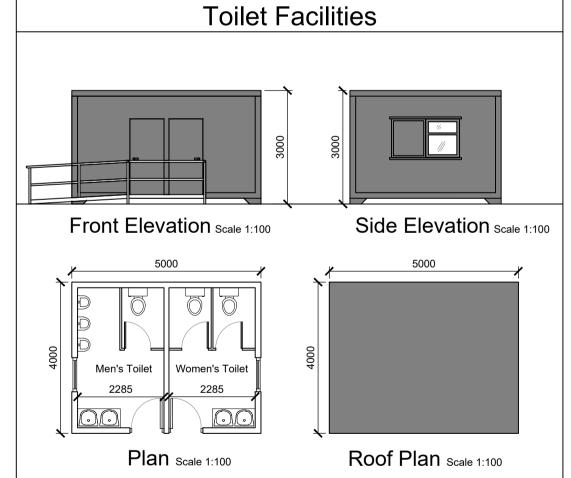

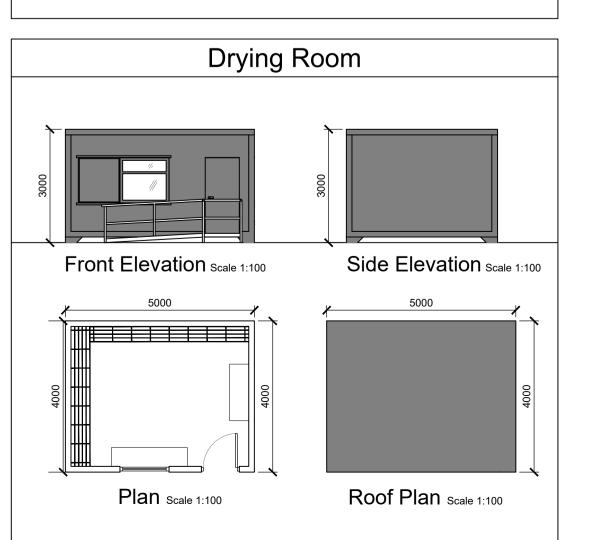

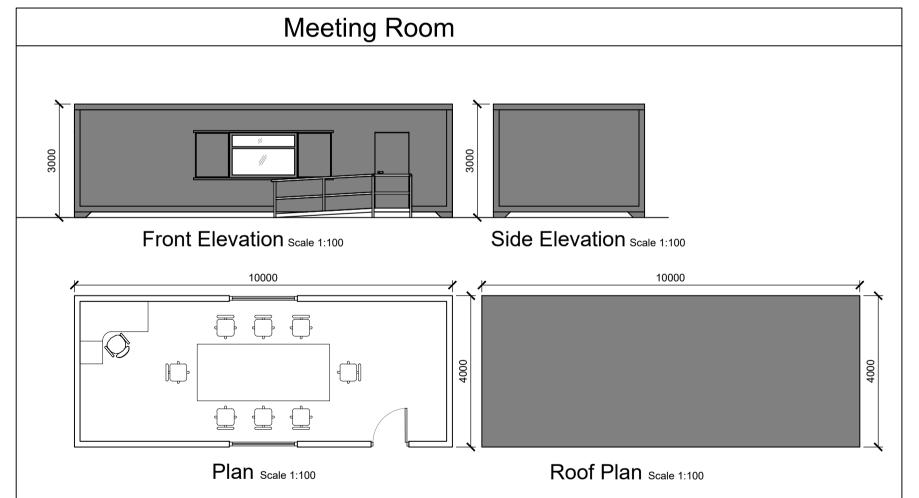

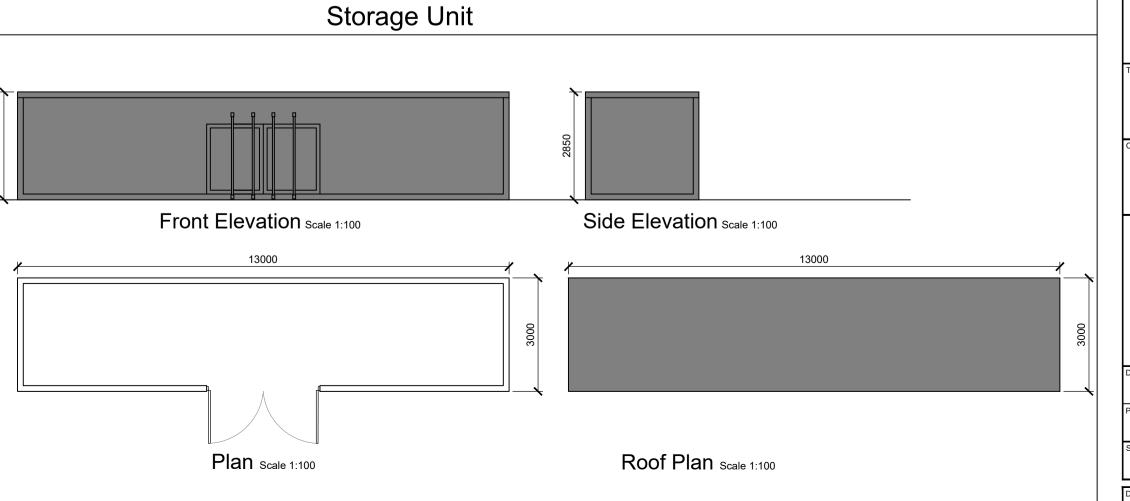

DO NOT SCALE FROM THIS DRAWING. USE FIGURED DIMENSIONS IN ALL CASES. VERIFY DIMENSIONS ON SITE AND REPORT ANY DISCREPANCIES TO THE VERIFY DIMENSIONS ON SITE AND REPORT ANY DISCREPANCIES TO THE DESIGNERS IMMEDIATELY.


THIS DRAWING TO BE READ IN CONJUNCTION WITH THE DESIGNERS SPECIFICATION.

© THIS DRAWING IS COPYRIGHT AND MAY ONLY BE REPRODUCED WITH THE DESIGNERS PERMISSION.

. ALL DRAWINGS ARE TO BE READ IN CONJUNCTION WITH ALL RELEVANT SPECIFICATIONS, BILLS OF QUANTITIES, ARCHITECTURAL, SERVICES AND ENGINEERING DRAWINGS.

- 2. ALL LEVELS ARE IN METRES RELATED TO ORDNANCE DATUM MALIN HEAD.
- 3. ANY DISCREPANCIES BETWEEN THESE DOCUMENTS SHALL BE BROUGHT TO THE ATTENTION OF THE ENGINEER.
- 4. DRAWINGS ARE NOT TO BE SCALED.
- 5. ALL DIMENSIONS ARE IN MILLIMETRES, UNLESS NOTED

KEY PLAN

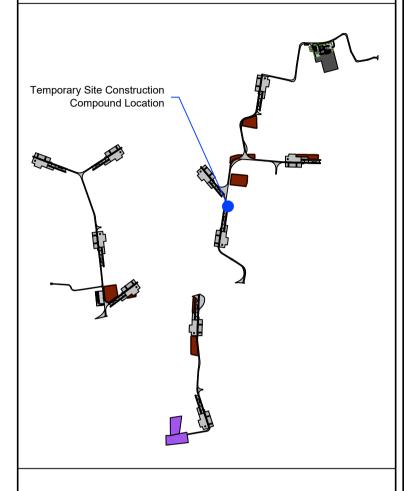

Brittas Wind Farm

Temporary Site Construction Compound No.2 Layout and Building Details

Brittas Wind Farm Ltd.

DRAWN:	CHECKED:	APPROVED:	
JK	CMcL	PC	
PROJECT NUMBER:	DATE:	SCALE @ A1:	
22318	May 2024	As Shown	
STATUS DESCRIPTION			STATUS:
FOR INFORMATION			S2

22318 - MWP - 00 - 00 - DR-C - 5412